

THE THE THE THE THE THE

FULLY SPRINKLERED

REFLECTED CEILING PLAN

RIGID GALVANIZED STEEL

SHORT CIRCUIT CAPACITY

SERVICE ENTRANCE SECTION

SINGLE POLE, SINGLE THROW

INTERNATIONAL SYSTEM OF UNITS

ROOT MEAN SQUARE

SMOKE DETECTOR

SPECIFICATION

SHUNT TRIP

SWITCHBOARD

SWITCHGEAR

TIME CLOCK

TELEPHONE

TELEVISION

TWISTED PAIR

TWISTED PAIR SHIELDED

UNDERFLOOR DUCT

UNDERGROUND

VOLT AMPERE

WATER HEATER

WEATHERPROOF

TRANSFORMER

TRANSFER

UTILITY

VOLTAGE

TELEPHONE TERMINAL BOARD

TAMPER RESISTANT, UL LISTED

UNDERWRITERS LABORATORY

VOLT AMPERE REACTIVE

VARIABLE FREQUENCY DRIVE

UNLESS OTHERWISE INDICATED

UNINTERRUPTIBLE POWER SUPPLY

SWITCH

SQUARE FOOT (FEET)

RECESSED

REQUIRED

ROOM

RECPT

RGS

RMS

REQD

SES

SHT

SPST

SW

TPS

UFD

UOI

UPS

UTIL

VAR

VFD

XFER

XFMR

UGND

SWBD

RECEPTACLE

PROJECT TITLE: DRAWING TITLE: PROJECT NUMBER SEAL: ARCHITECT/ENGINEERS: CONSULTANTS: 61804 SYMBOLS, NOTES, & **EXPAND EMERGENCY ABBREVIATIONS** BUILDING NUMBER ROOM brg3Sarchitects **1661 INTERNATIONAL DRIVE** 11 W. Huling Avenue Allen&Hoshall Memphis, Tennessee 38103 Memphis, Tennessee 38120 DRAWING NUMBER t 901.820.0820 t 901.260.9600 PPROVED PROJECT DIRECTOR: VAMC, Memphis, Tennessee since 1915 f 901.683.10017 f 301.531.8042 E00' ENGINEERS www.allenhoshall.com w brg3s.com REVISED ELECTRICAL SYMBOLS RTH May 31, 2012 FJW

FIXTURE MOUNTING FIXTURE TYPE ___LENS WH-WHITE BA-BRUSHED ALUMINUM A-ACRYLIC F-FLUORESCENT R-RECESSED A12-ACRYLIC S-SURFACE I-INCANDESCENT MS-MANUFACTURER'S NI-SATIN NICKEL LED - LIGHT EMITTING #12 PATTERN .125 THICK STANDARD SS-STAINLESS STEEL
DIODE G- GLASS PR-PFWTFR P-PENDANT SR-SEMI RECESSED PR-PEWTER PC- POLYCARBONATE SBA - SELECTED BY ARCHITECT FIX. FIX. LENS FIN. LAMP LAMP MIN. VOLTS COMMENTS TEMP. CRI MANUF'R CATALOG NO. R LED - MS - 47 5000 82 120/277 LED VOLUMETRIC 2X4 TROFFER, W/ nLIGHT 2VTL4 48L ADP D47 LP850 N80 R LED - MS - 47 5000 82 120/277 LED VOLUMETRIC 2X2 TROFFER, W/ nLIGHT 2VTL2 24L ADP D24 LP850 N80 R LED - PR - 29 4100 85 277 4" LED DOWNLIGHT B GOTHAM ALED 41/18 4PR 277 R LED - PR - 29 4100 85 277 4" LED DOWNLIGHT W/ nLIGHT B1 GOTHAM ALED 41/18 4PR 277 NSD R LED - PR - 48.6 3500 85 277 8" LED DOWNLIGHT - DAMP LOCATION R F - MS 2 32 5000 85 277 WET LOCATION TROFFER WRT F 232 A12125 MVOLT GEB10RS E1 EMERGI-LITE LPEX 102 AA S LED - BA - - - 120/277 EXIT, SINGLE FACE, UNIVERSAL MOUNT S LED - BA - - - 120/277 EXIT, DOUBLE FACE, UNIVERSAL MOUNT E2 EMERGI-LITE LPEX 103 AA P F - MS 2 32 5000 80 120/277 SUSPENDED FLUORESCENT STRIP f Lithonia C232 MVOLT SQ4 S LED - S - 24 3500 80 120/277 LIGHTED BOLLARD VRB1 20L 3K UV PS J HEALTHCARE LIGHTING HPW24-120-T8EL-22-SX-CS BD-AM W F - WH 4 32 5000 82 120 PATIENT HEADWALL FIXTURE | W | F | - | WH | 3 | 32 | 5000 | 82 | 277 | 2'X4' BEHAVIORAL HEALTH FIXTURE MMAC24 F 1/1 9 332 IS 2 2 N LITECONTROL 2114 T5 CWM LP/ELB G SSR R F - SBA 1 28 5000 82 277 PERIMETER FIXTURE

P aLIGHT G3-4-H-U-A-C-Q R F - SBA 1 54 5000 82 277 RECESSED CANOPY FIXTURE FIXTURE SCHEDULE: 1. FIXTURE TYPE "J" TO BE PART OF DEDUCTIVE ALTERNATE #5. BASE BID INCLUDES HILLROOM PACKAGE WHICH INCLUDE OVERBED FIXTURE. PROVIDE FIXTURE TYPE

- "J" FOR DEDUCTIVE ALTERNATE # 5.
- 2. PROVIDE SENSORWITCH DUAL RELAY POWER PACK, PART # nSP5 SP TO CONTROL UP AND DOWN LIGHT SEPERATELY. SEE NOTES ON LIGHTING PLAN.
- 3. PROVIDE ALL END CAPS, STRAIGHT EXTENSIONS, INSIDE CORNER, OUTSIDE CORNERS, ETC FOR A COMPLETE INSTALLATION. COORDINATE WITH ARCHITECTURAL CEILING PLAN.

ALL FLUORESCENT BALLASTS SHALL BE ELECTRONIC 10% ≤ THD, UOI.

SEISMIC MOUNTING NOTES: SEE E003. EACH PENDANT FIXTURE SHALL HAVE ONE ZINC COATED, HIGH STRENGTH, STEEL ROPE CABLE WITH CONNECTIONS. DESIGNED FOR CABLE SERVICE RUN BETWEEN FIXTURE AND STRUCTURE ABOVE. EACH RECESSED TROFFER SHALL HAVE INDIVIDUAL TIE STRINGERS AND BOLTED CONNECTION TO THE GRID OR FLANGE.

ALL FIXTURES SHALL MEET THE BUY AMERICAN PROVISIONS IN THE AMERICAN RECOVERY

IN EACH ROOM. CONTRACTOR TO AQUIRE WIRING DIAGRAM/SHOP DRAWINGS FROM SENSORSWITCH. PROVIDE ALL LOW VOLTAGE WIRING, CONTROLS, RELAYS AND POWER PACKS FOR A COMPELTE SYSTEM.

FIXTURE SCHEDULE - ELECTRICAL

FULLY SPRINKLERED

	CONSULTANTS:	SEAL:	ARCHITECT/ENGINEERS:		FIXTURE SCHEDULE	PROJECT TITLE: EXPAND EMERGENCY	PROJECT NUMBER: 61804
	Allen&Hoshall	1661 INTERNATIONAL DRIVE Memphis, Tennessee 38120 t 901.820.0820 f 901.683.10017	brg3Sarchitects	11 W. Huling Avenue Memphis, Tennessee 38103 t 901.260.9600 f 301.531.8042	SCALE: NONE	ROOM	BUILDING NUMBER:
					APPROVED PROJECT DIRECTOR:	VAMC, Memphis, Tennessee	E002
REVISED FIXTURE SCHEDULE 11/22/2013 Revisions: Date:	ENGINEERS	www.allenhoshall.com		w brg3s.com		May 31, 2012 CHECKED: DRAWN:	DWG. OF

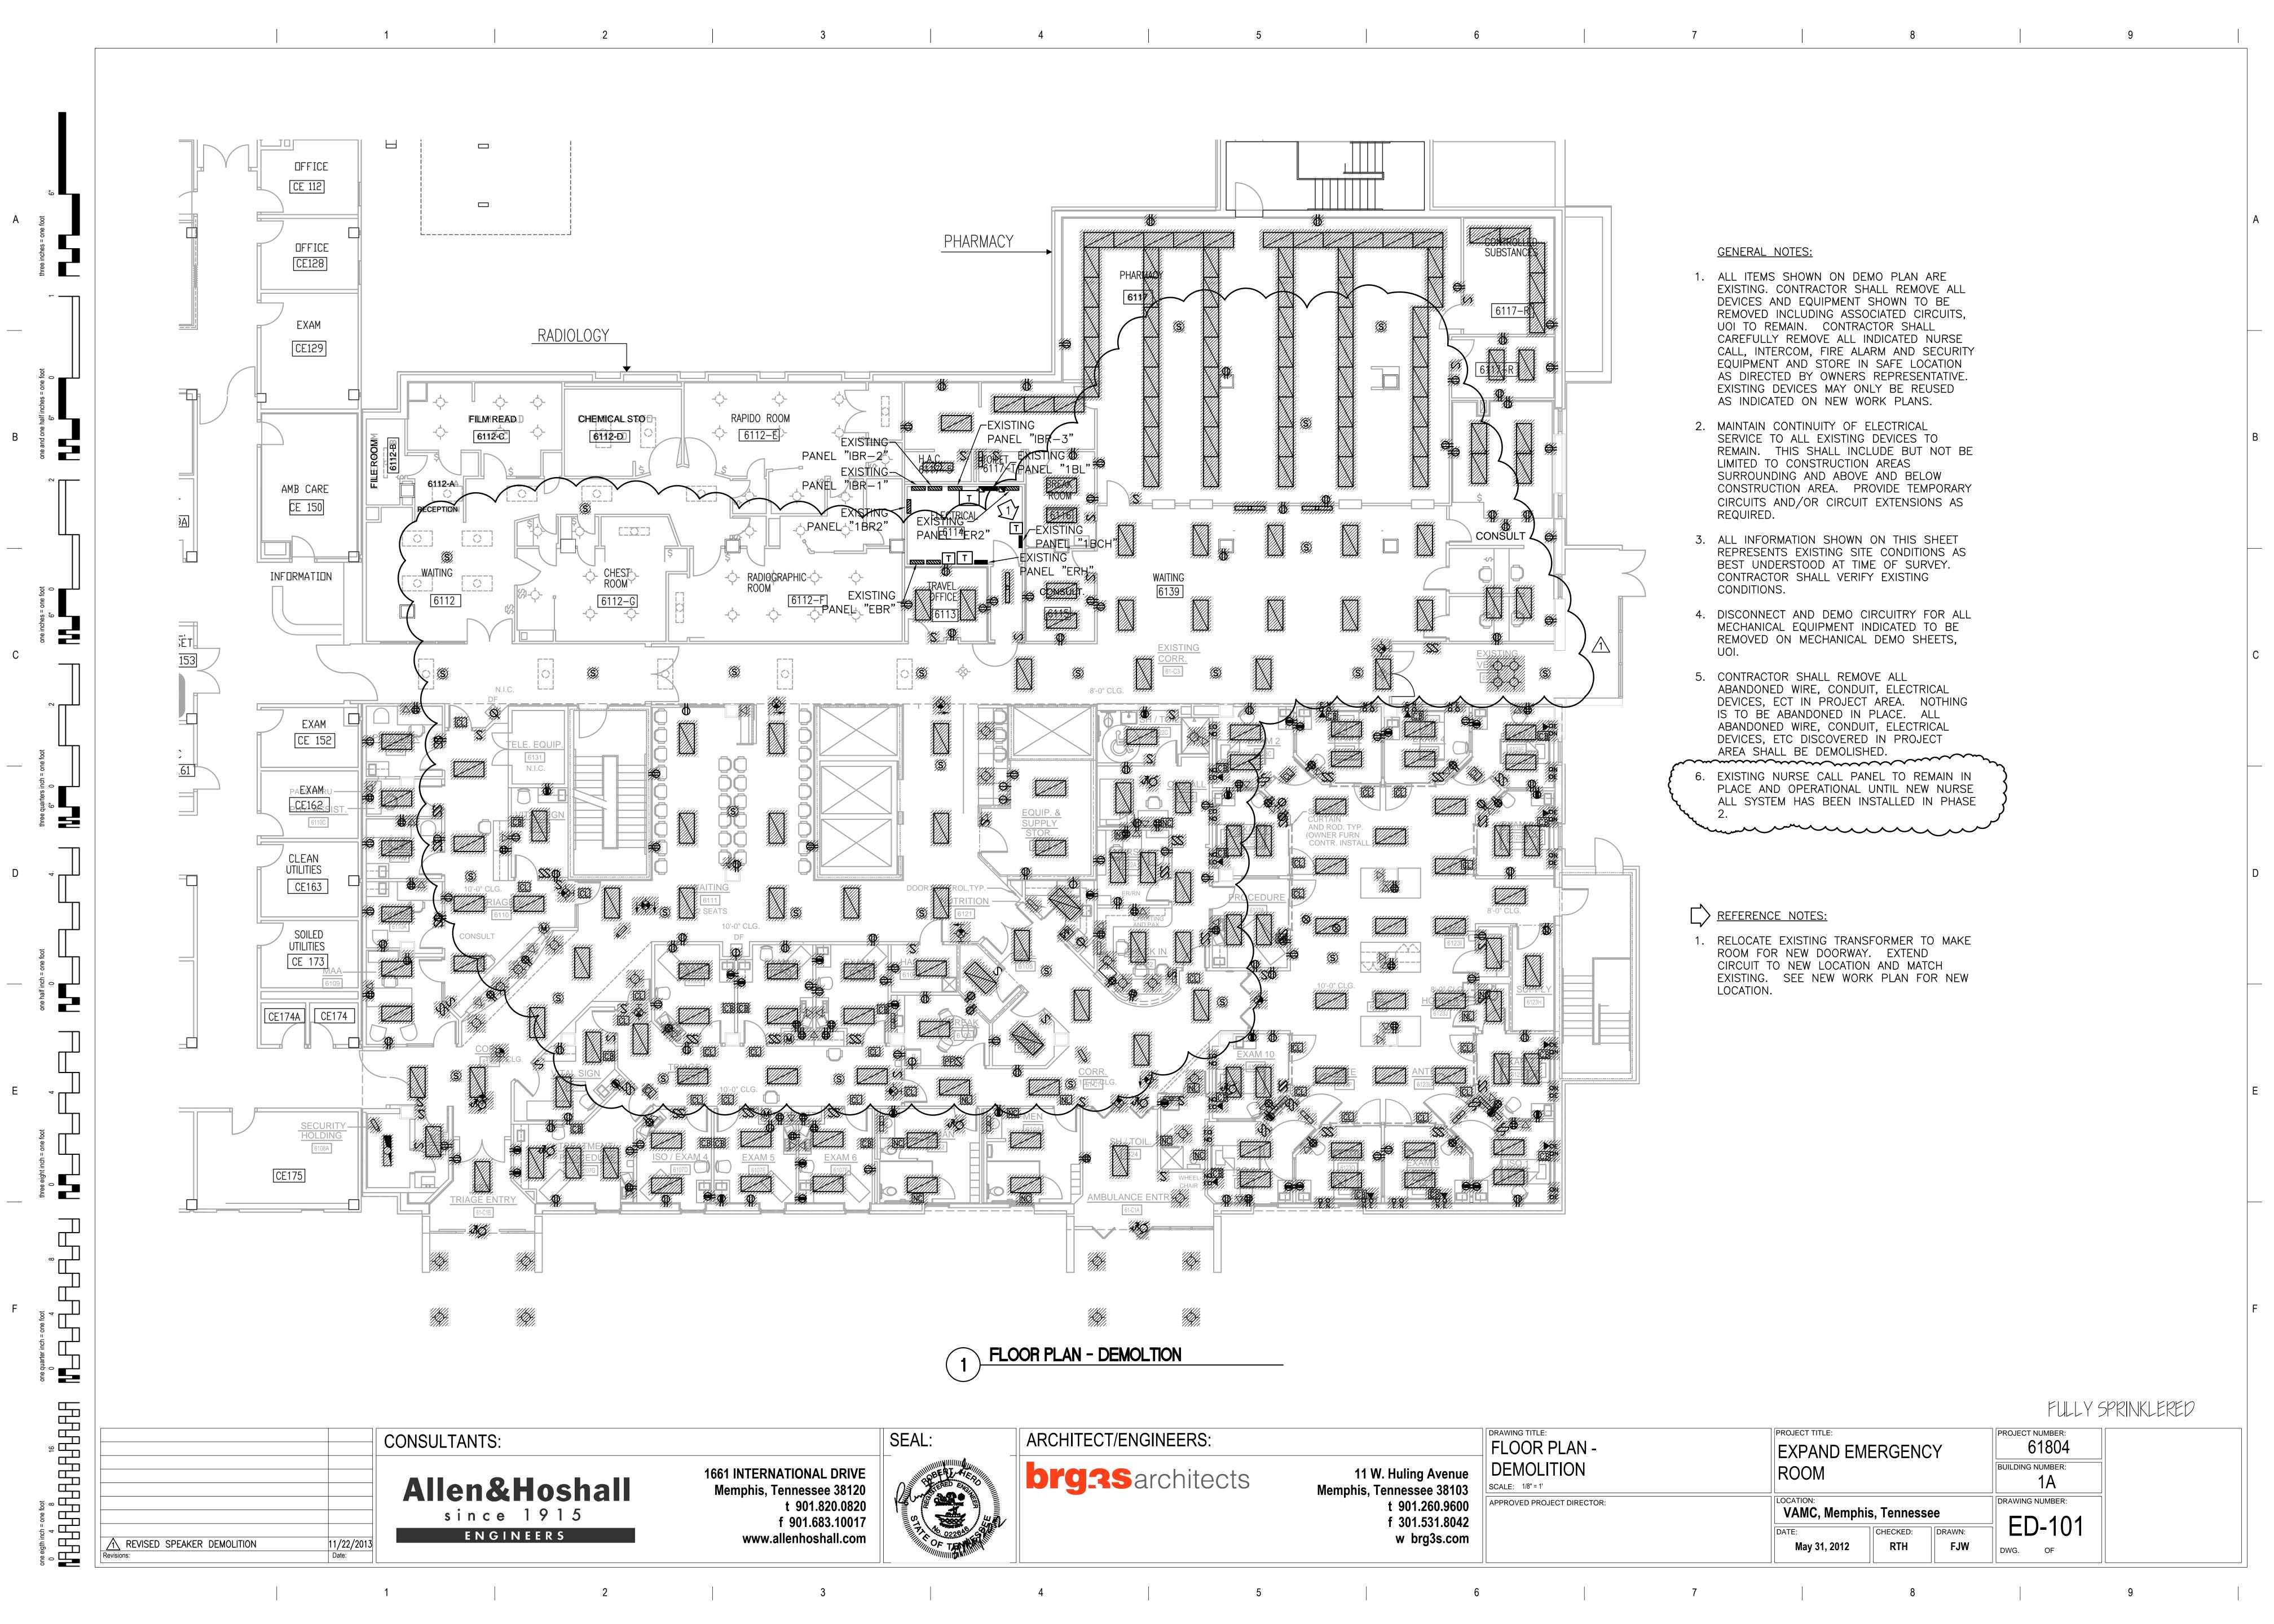
2 5 7

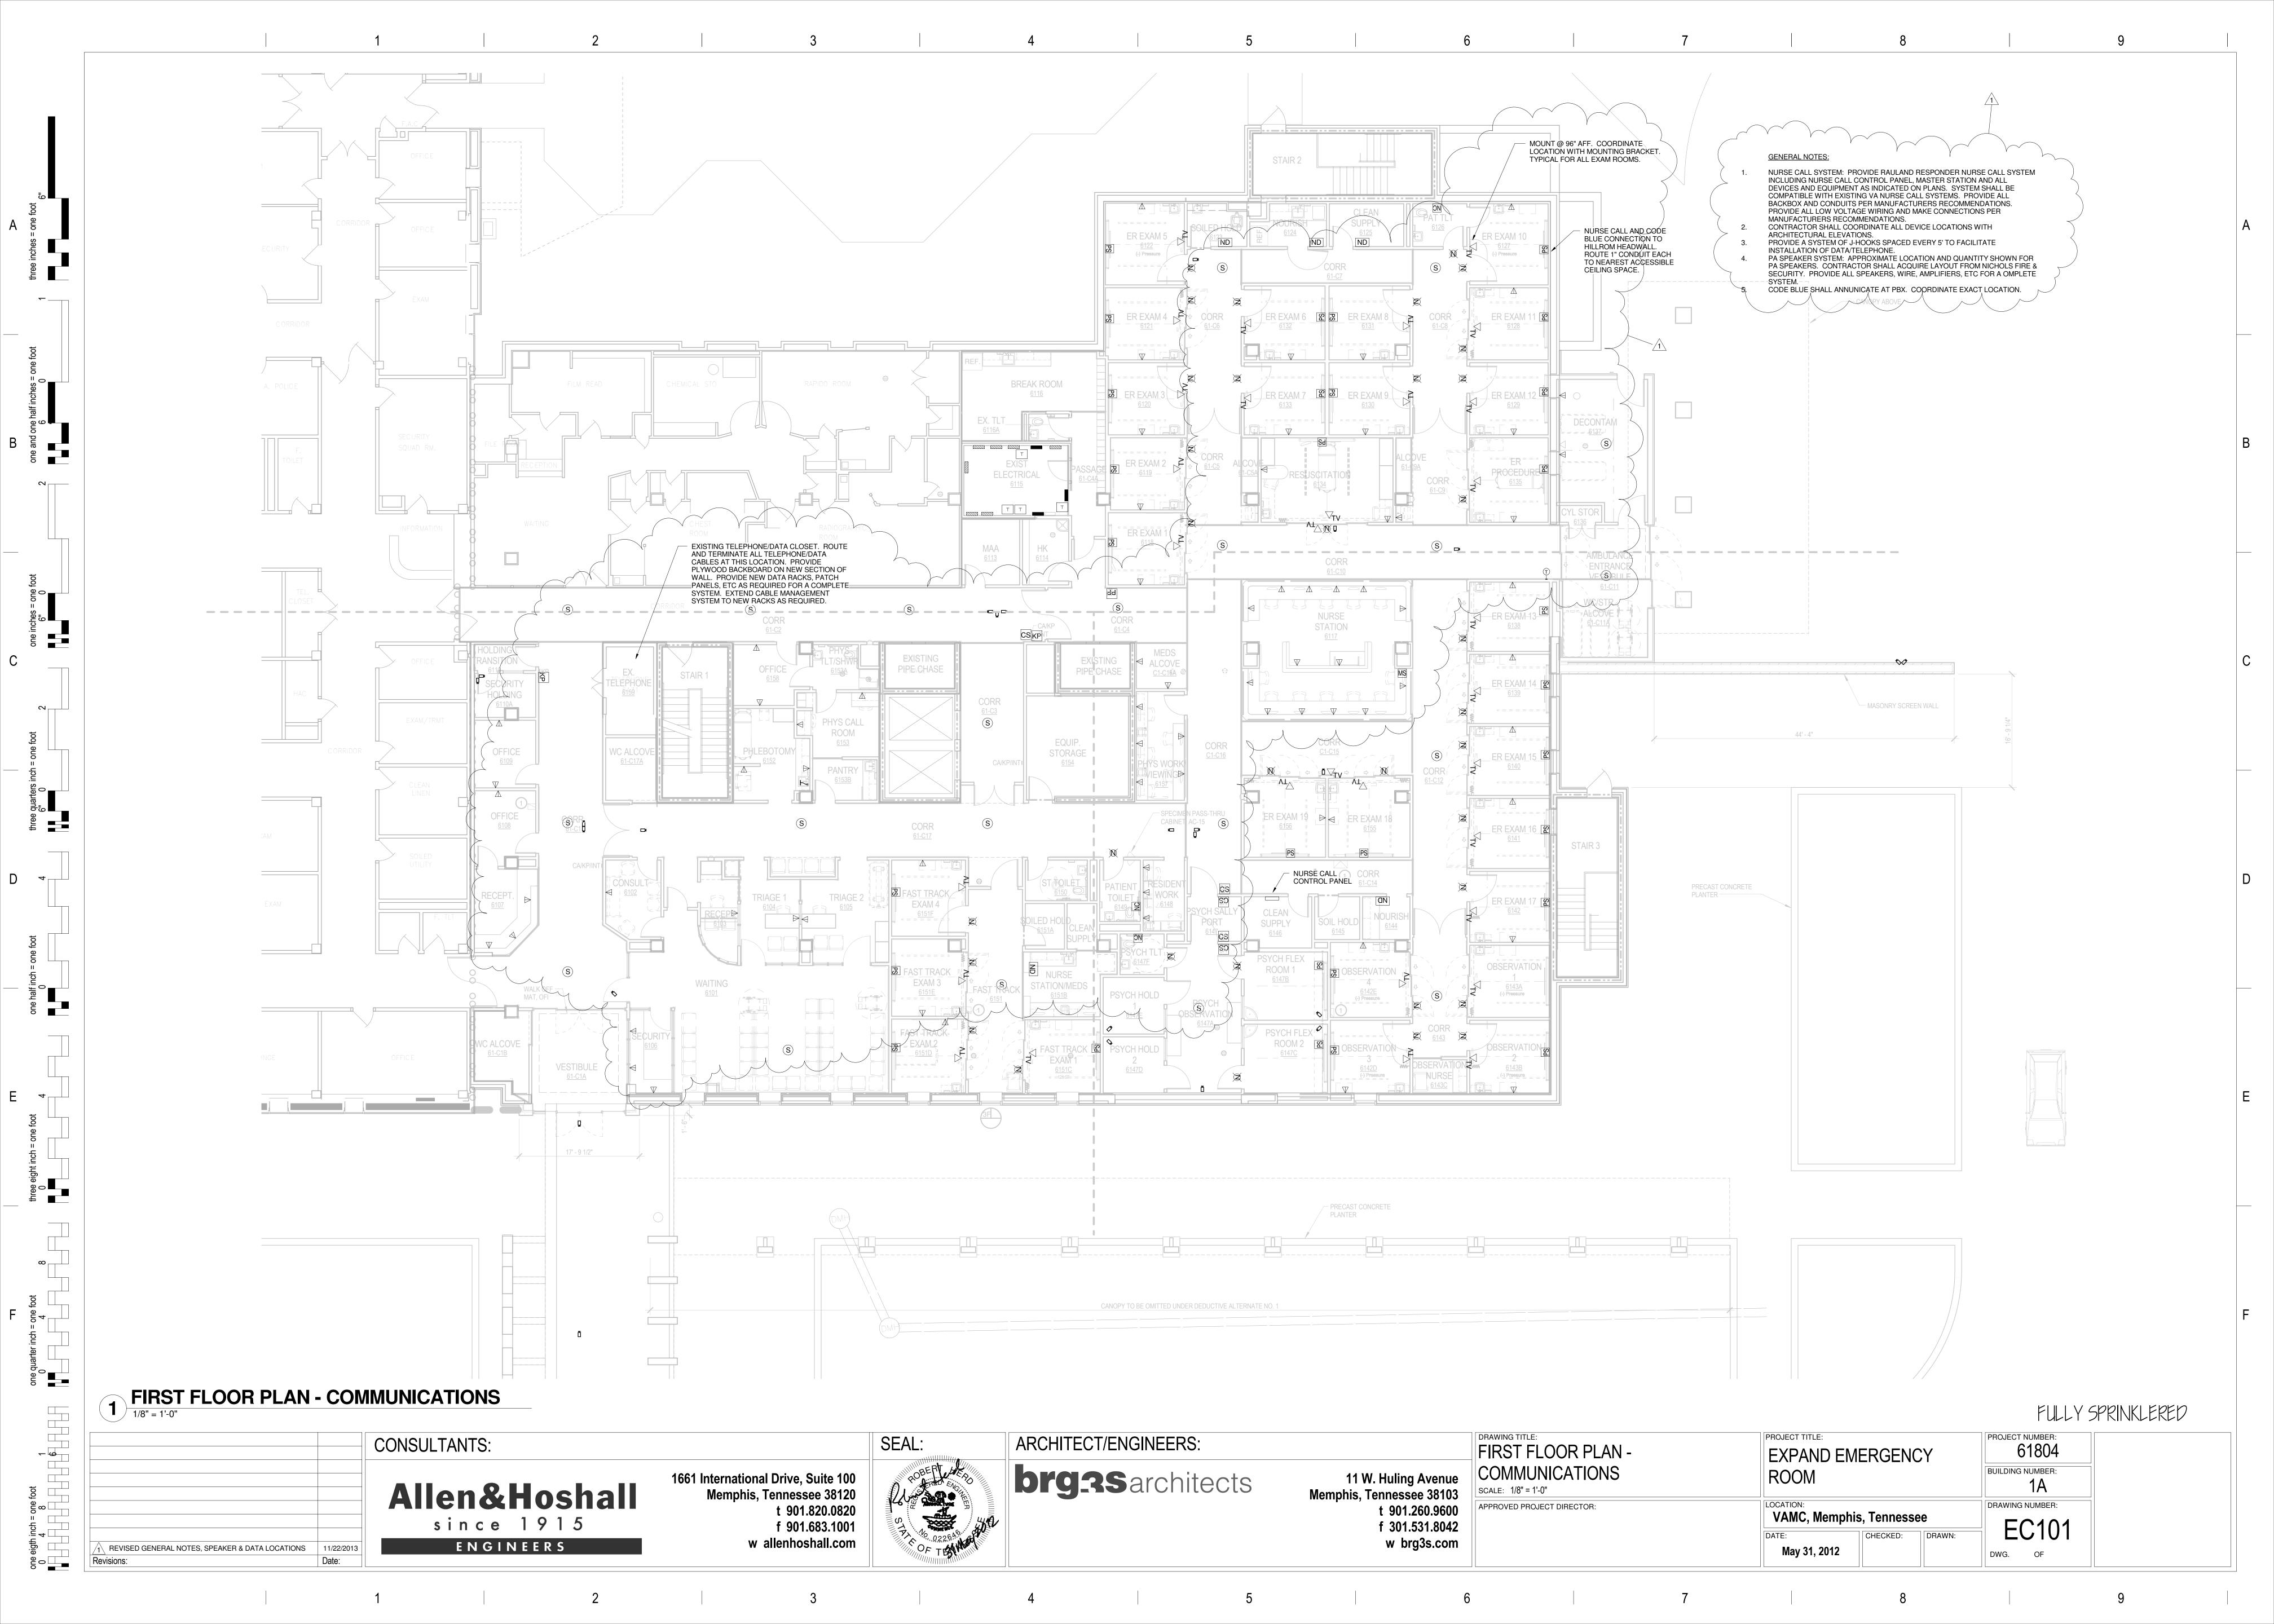
one eigth inch = one foot

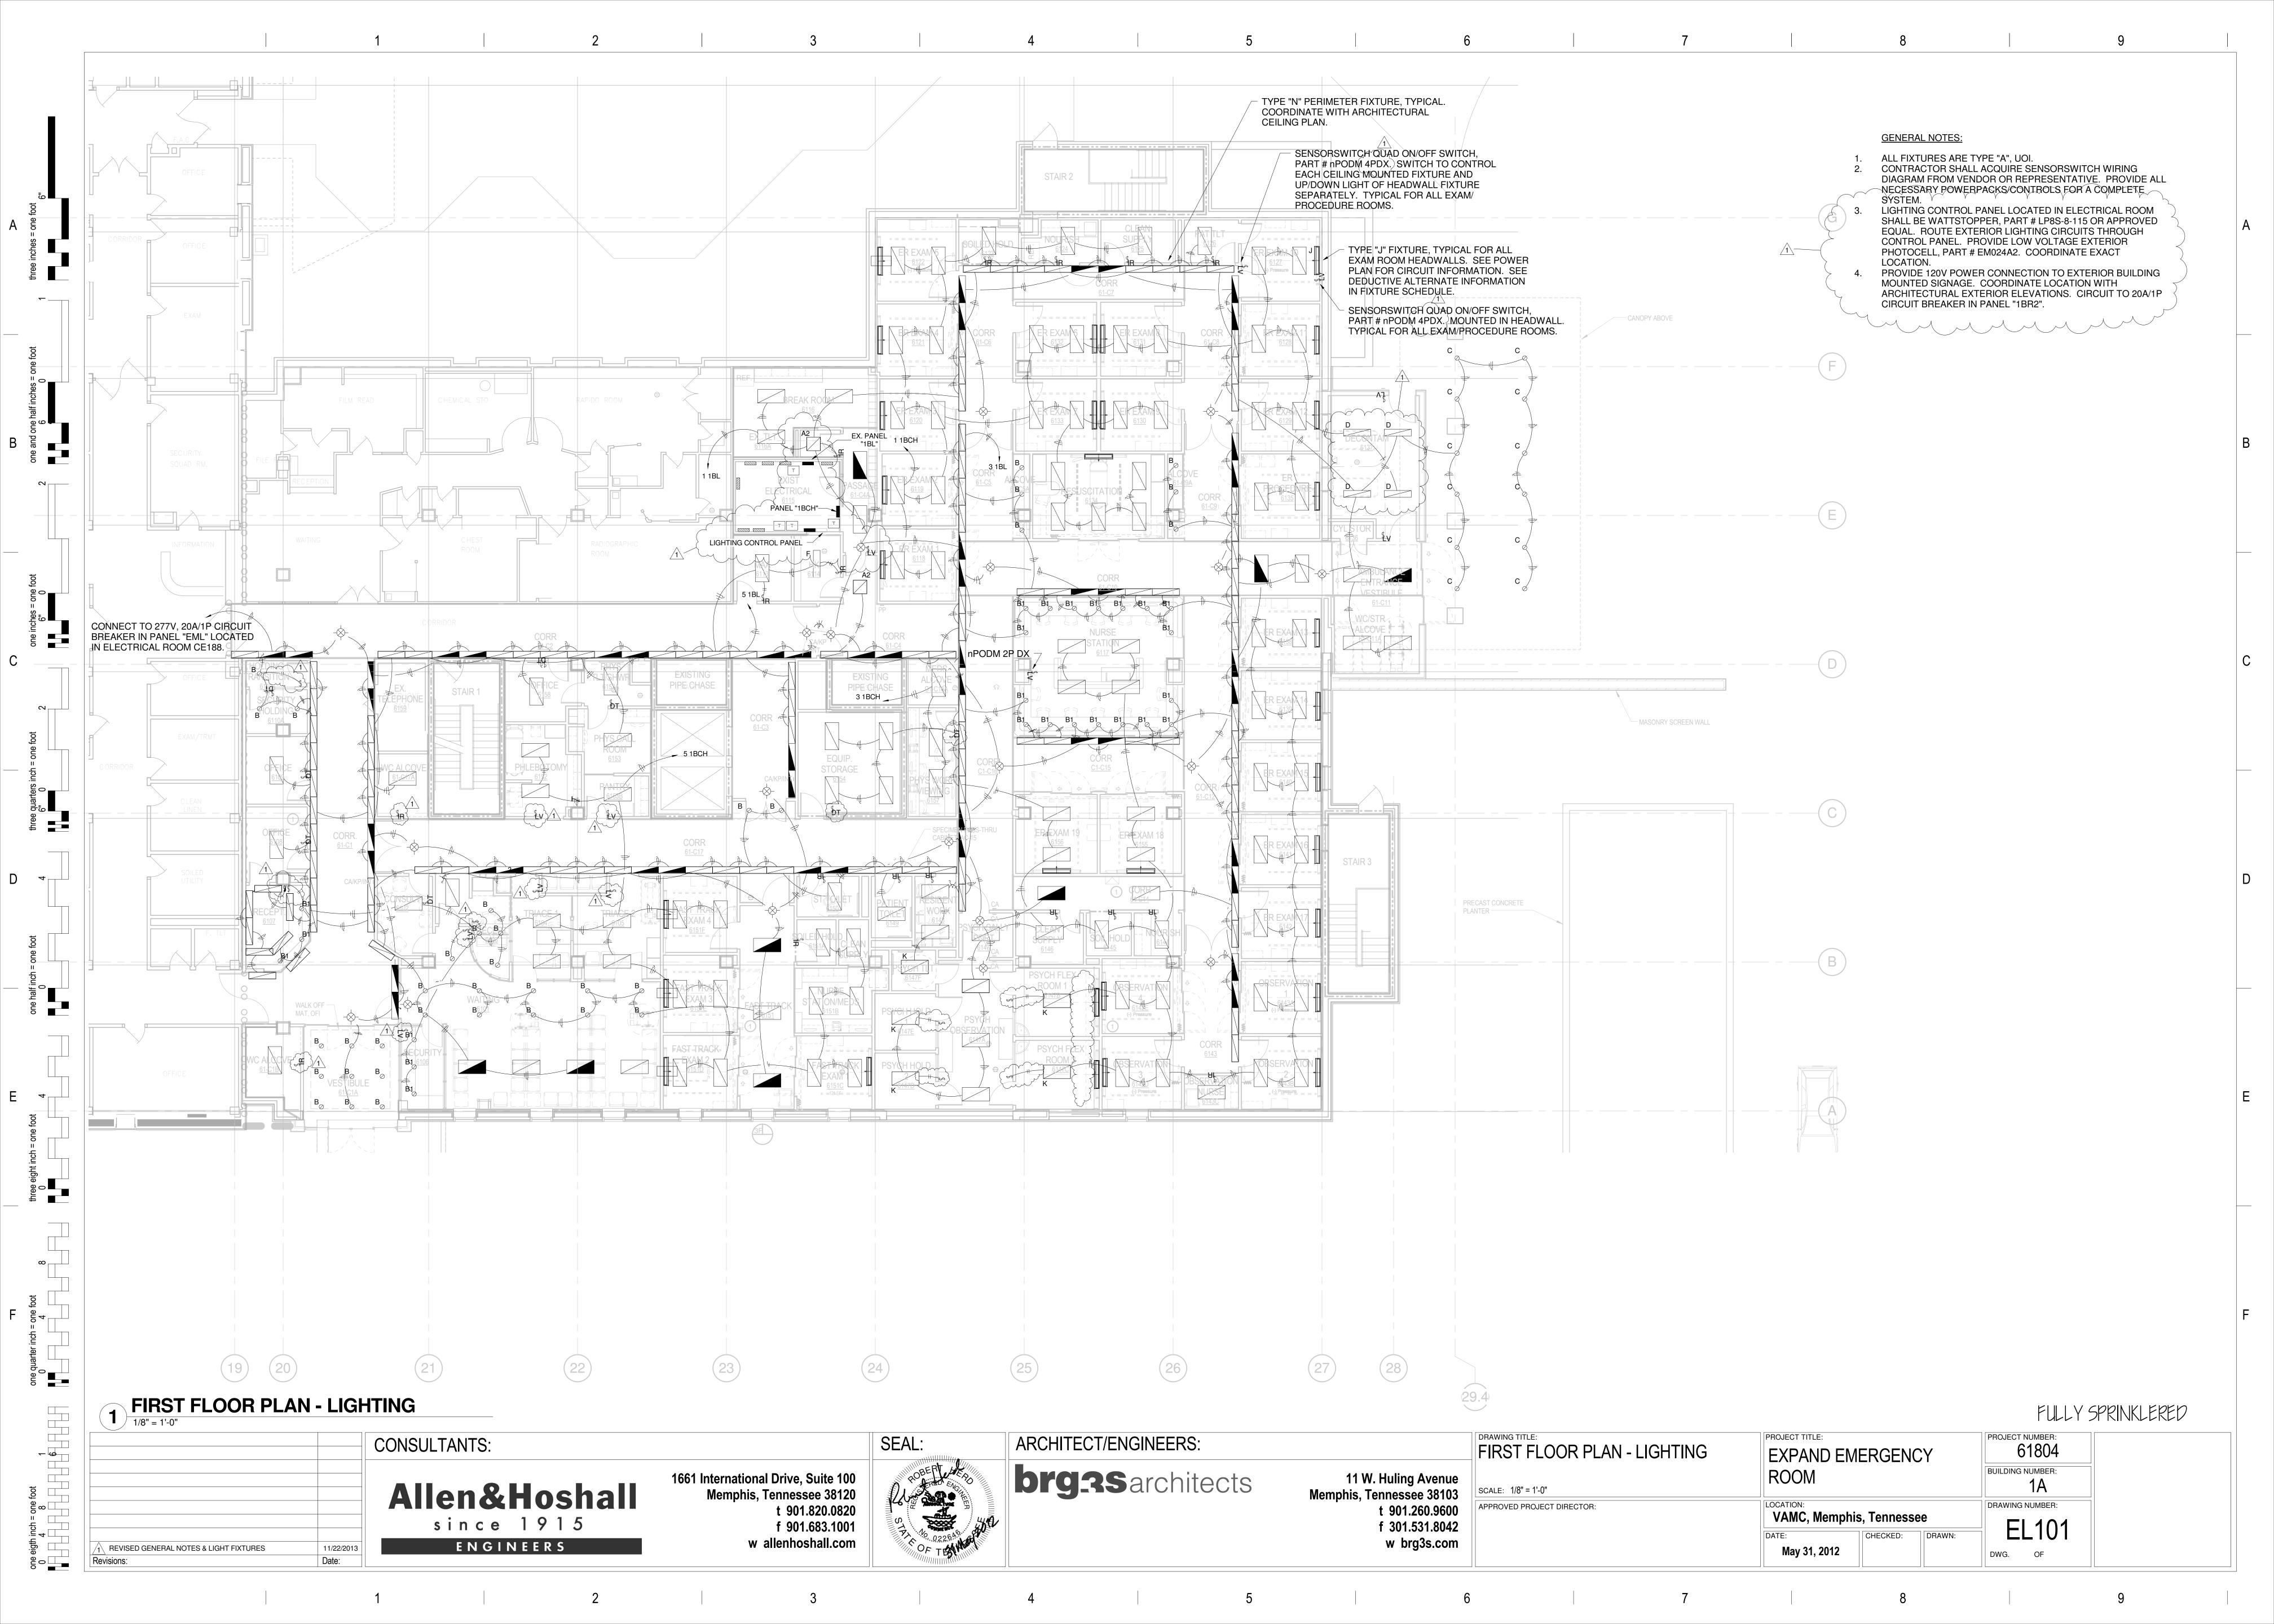
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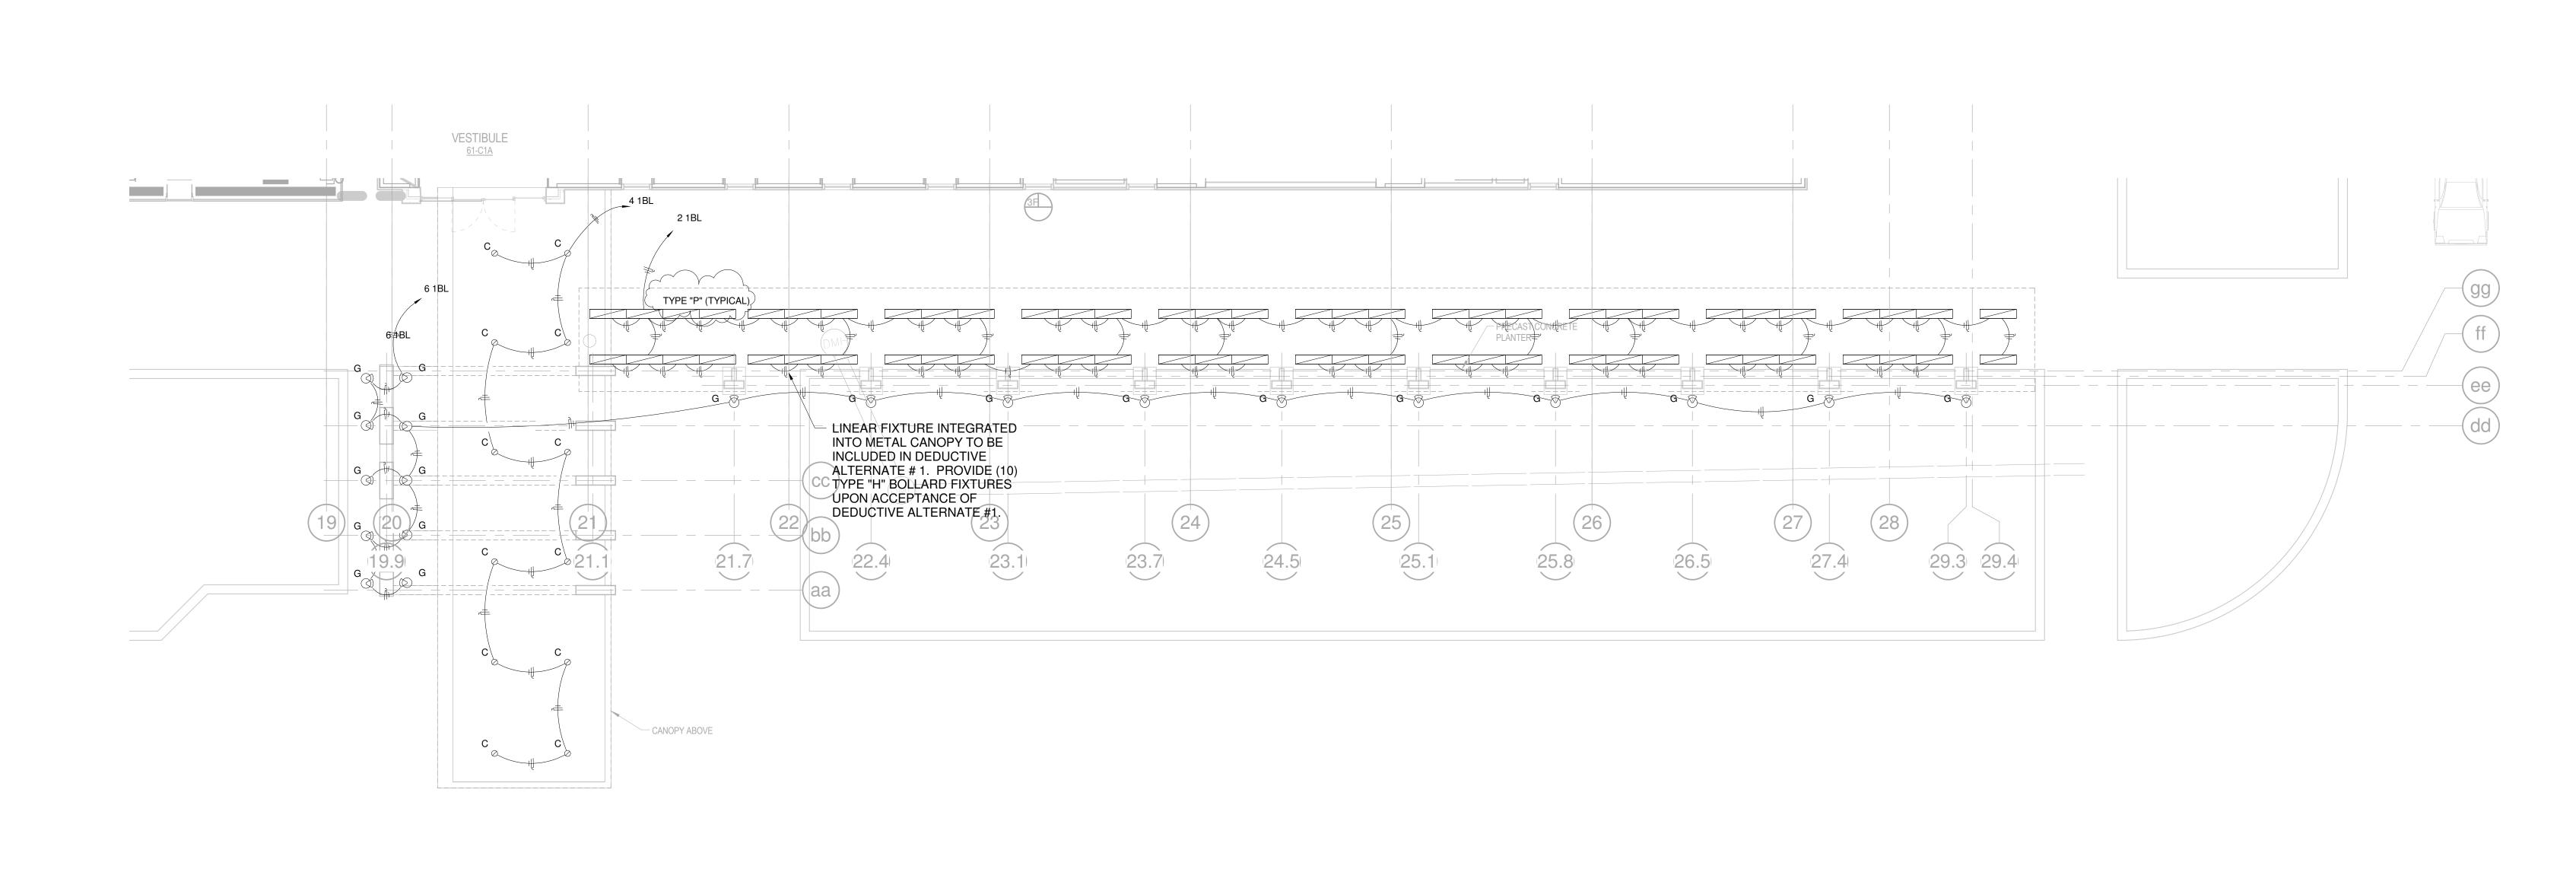
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ENTRANCE CANOPY PLAN - LIGHTING

1/8" = 1'-0"

one quarte

FULLY SPRINKLERED

		CONSULTANTS:		SEAL:	ARCHITECT/ENGINEERS:		ENTRANCE CANOPY PLAN -	PROJECT TITLE: EXPAND EMERGENCY	PROJECT NUMBER: 61804
			1661 International Drive, Suite 100	POBERT LEADING	brg3 Sarchitects	11 W. Huling Avenue	LIGHTING SCALE: 1/8" = 1'-0"	ROOM	BUILDING NUMBER:
		Allen&Hoshall	Memphis, Tennessee 38120 t 901.820.0820	SY SY STATE OF THE		Memphis, Tennessee 38103 t 901.260.9600	APPROVED PROJECT DIRECTOR:	VAMC, Memphis, Tennessee	DRAWING NUMBER:
1 REVISED CANOPY FIXTURE TYPE	11/22/2013	since 1915 ENGINEERS	f 901.683.1001 w allenhoshall.com	022640 OF TEN		f 301.531.8042 w brg3s.com		DATE: CHECKED: DRAWN:	EL102
Revisions:	Date:								DWG. OF

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